


10. REMOVE AND DISPOSE OF 7 EXISTING TREES. GRIND ALL STUMPS AND REMOVE GROUND MATERIAL. BACKFILL WITH COMPACTED GAB.

NOTES:

- ADJUST DRAINAGE PIPE LOCATION AS NECESSARY TO AVOID PLAYGROUND EQUIPMENT.
- LAYOUT OF PIPING & DRAINAGE GRAVEL TO BE APPROVED BY THE CITY'S REPRESENTATIVE PRIOR TO PLACING WOOD CARPET MULCH.
- ALL SITE LUMBER TO BE PRESSURE TREATED SOUTHERN YELLOW PINE, GRADE #1, FOLLOWING THE AWPA STANDARDS U1 CATEGORY UC4A FOR GROUND CONTACT (0.40 PCF ACQ TREATMENT).
- ALL FASTENERS ARE TO BE HOT DIPPED GALVANIZED.
- PLAYGROUND AND WALKWAY EDGES SHALL BE "DRESSED OUT" TO AN EVEN LEVEL GRADE. SHAPE & FINISH CUT SLOPES, FILL SLOPES AND EMBANKMENT MEETS OR OTHER AREAS EFFECTED BY THE NEW PATH / PLAYGROUND CONSTRUCTION. BACKFILLED EDGES SHALL BE FREE OF G.A.B., ROCKS, BRICKS, BOULDERS, OR OTHER CONSTRUCTION DEBRIS.
- DRESS OUT SHALL BE CONDUCTED IN A MANNER SO AS TO CAUSE NO DAMAGE TO OTHER SURFACES, STRUCTURES OR EDGES. ANY DAMAGED AREAS SHALL BE IMMEDIATELY REPAIRED AT NO COST TO THE OWNER.
- TIF GRAND BERMUDA SOD SHALL COVER ALL DISTURBED AREAS IMMEDIATELY AFTER CONSTRUCTION IS COMPLETED TO MINIMIZE EROSION.
- CONTRACTOR SHALL STAKE THE PLAYGROUND AREAS AND WALKWAYS IN THE FIELD PRIOR TO CONSTRUCTION. THE CONTRACTOR SHALL BE RESPONSIBLE TO NOTIFY OWNER'S REPRESENTATIVE THAT THE AREAS ARE READY TO BE WALKED TO DETERMINE IF ADJUSTMENTS IN ALIGNMENT ARE REQUIRED TO AVOID TREES OR MINIMIZE CROSS-SLOPE CONSTRUCTION. THE CONTRACTOR SHALL ANTICIPATE RE-STAKING FOR OWNER'S APPROVAL AT NO ADDITIONAL COST TO THE OWNER.
- CONTRACTOR SHALL PROVIDE A CONSTRUCTION ENTRANCE OR WHEEL WASH AREA TO TAKE THE NECESSARY ACTION TO MINIMIZE THE TRACKING OF MUD ONTO PAVED ROADWAY FROM CONSTRUCTION SITE. THE CONTRACTOR SHALL DAILY REMOVE MUD/ SOIL FROM PAVEMENT, AS REQUIRED.

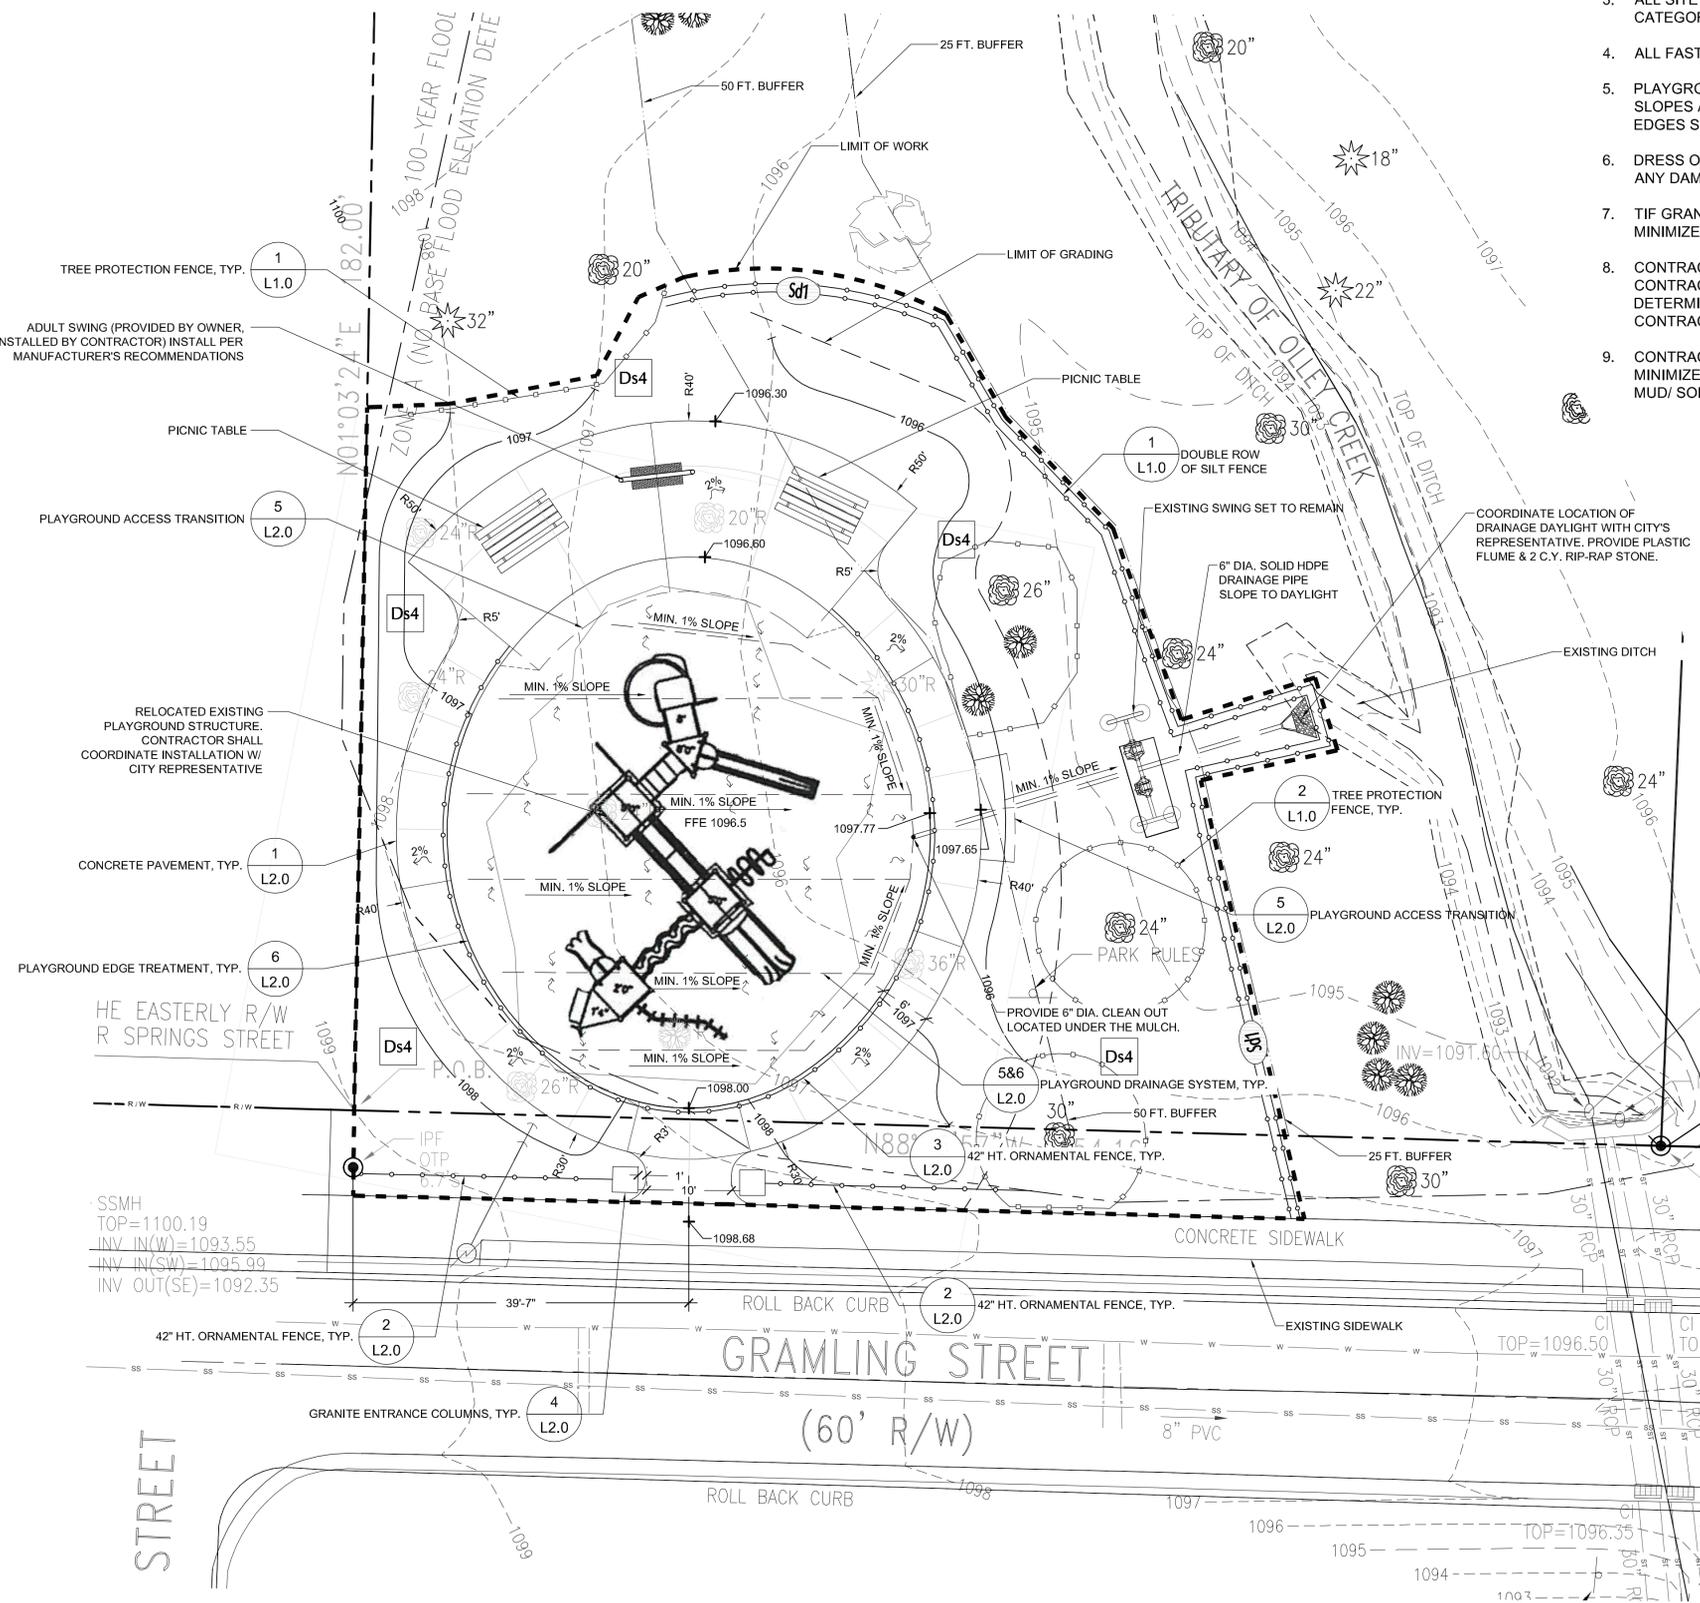

1 TREE PROTECTION FENCE, TYP. L1.0
 ADULT SWING (PROVIDED BY OWNER, INSTALLED BY CONTRACTOR) INSTALL PER MANUFACTURER'S RECOMMENDATIONS
 5 PICNIC TABLE L2.0
 5 PLAYGROUND ACCESS TRANSITION L2.0

1 RELOCATED EXISTING PLAYGROUND STRUCTURE. CONTRACTOR SHALL COORDINATE INSTALLATION W/ CITY REPRESENTATIVE L2.0
 1 CONCRETE PAVEMENT, TYP. L2.0
 6 PLAYGROUND EDGE TREATMENT, TYP. L2.0

SSMH
 TOP=1100.19
 INV IN(W)=1093.55
 INV IN(SW)=1095.99
 INV OUT(SE)=1092.35


2 42" HT. ORNAMENTAL FENCE, TYP. L2.0
 4 GRANITE ENTRANCE COLUMNS, TYP. L2.0

PROJECT INFORMATION:
 LIMIT OF WORK: 10,005.52 S.F. (0.23 ACRES)
 AREA OF CUT: 1,971 C.F.
 AREA OF FILL: 895 C.F.


DEVELOPER/OWNER:
 CITY OF MARIETTA
 PARKS AND RECREATION DEPARTMENT
 205 LAWRENCE STREET
 MARIETTA, GA 30060
 PHONE: 770.794.5601
 FAX: 770.794.5635
 CONTACT: RICH DECKMAN

24-HOUR LOCAL EROSION & SEDIMENT CONTROL CONTACT:
 MR. RICH DECKMAN
 PHONE: 770.656.9054
 LAND LOT NUMBER: 218
 DISTRICT NUMBER: 17TH
 COUNTY: COBB

EROSION CONTROL MEASURES WILL BE MAINTAINED AT ALL TIMES. IF FULL IMPLEMENTATION OF THE APPROVED PLAN DOES NOT PROVIDE FOR EFFECTIVE EROSION CONTROL, ADDITIONAL EROSION AND SEDIMENT CONTROL MEASURES SHALL BE IMPLEMENTED TO CONTROL OR TREAT THE SEDIMENT SOURCE, OR AS DIRECTED BY THE EROSION CONTROL INSPECTOR.

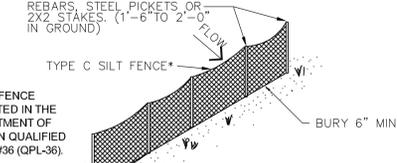

1 Sd1 TEMPORARY SEDIMENT BARRIER TYPE 'C'
 Scale: N.T.S.

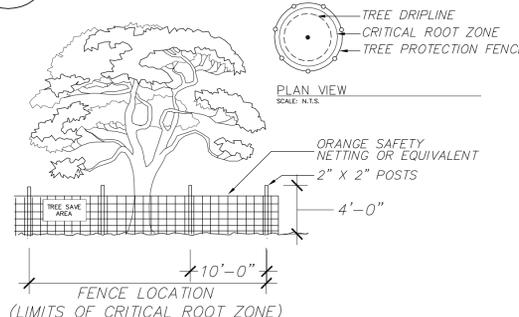

2 TREE PROTECTION FENCING
 Scale: N.T.S.

GEORGIA UNIFORM CODING SYSTEM FOR SOIL EROSION AND SEDIMENT CONTROL PRACTICES

CODE	PRACTICE	DETAIL	MAP SYMBOL	DESCRIPTION
Sd1	SEDIMENT BARRIER			A barrier to prevent sediment from leaving the construction site. It may be sandbags, sales of straw or hay, gravel or a sediment fence. The barriers are usually temporary and inexpensive.
Ds4	DISTURBED AREA STABILIZATION (w/SODDING)			Establishing permanent vegetative cover with of grand bermuda sod.

CERTIFICATION STATEMENTS:
 1. I CERTIFY UNDER PENALTY OF LAW THAT THIS PLAN WAS PREPARED AFTER A SITE VISIT TO THE LOCATIONS DESCRIBED HEREIN BY MYSELF OR MY AUTHORIZED AGENT, UNDER MY SUPERVISION
 2. * I CERTIFY THAT THE PERMITTEE'S EROSION SEDIMENTATION AND POLLUTION CONTROL PLAN PROVIDES FOR AN APPROPRIATE AND COMPREHENSIVE SYSTEM OF BEST MANAGEMENT PRACTICES REQUIRED BY THE GEORGIA WATER QUALITY ACT AND THE DOCUMENT "MANUAL FOR EROSION AND SEDIMENT CONTROL IN GEORGIA" (MANUAL) PUBLISHED BY THE STATE SOIL AND WATER CONSERVATION COMMISSION AS OF JANUARY 1 OF THE YEAR IN WHICH THE LAND DISTURBING ACTIVITY WAS PERMITTED, PROVIDES FOR THE SAMPLING OF THE RECEIVING WATER (S) OR THE SAMPLING OR THE STORM WATER OUTFALLS AND THAT THE DESIGNED SYSTEM OF BEST MANAGEMENT PRACTICES AND SAMPLING METHODS IS EXPECTED TO MEET REQUIREMENTS CONTAINED IN THE GENERAL NPDES PERMIT NO. GAR 100001.

CERTIFIED PROFESSIONAL _____ CERT. # 24054
 E. RICHARD DECKMAN

NO.	DATE	DESCRIPTION
01	08/11/14	ADDENDUM 01

date 06/13/2014
 project no. 14037.0
 drawn by CWE
 checked by SP
 sheet title

LAYOUT PLAN